
TOWN OF MOULTONBOROUGH, NEW HAMPSHIRE 2012 ROAD PROGRAM - SHERIDAN ROAD



INDEX

SHEET NO.	DESCRIPTION
COVER	COVER SHEET
1	GENERAL NOTES AND LEGEND
2	PLAN AND PROFILE STA 9+50 TO 18+00
3	PLAN AND PROFILE STA 18+00 TO 25+00
4	CROSS SECTIONS STA 9+50 TO 15+00
5	CROSS SECTIONS STA 15+50 TO 21+00
6	CROSS SECTIONS STA 21+50 TO 25+00 AND TYPICAL ROADWAY SECTIONS
7	ROADWAY AND MISCELLANEOUS DETAILS
8	DRAINAGE AND MISCELLANEOUS DETAILS

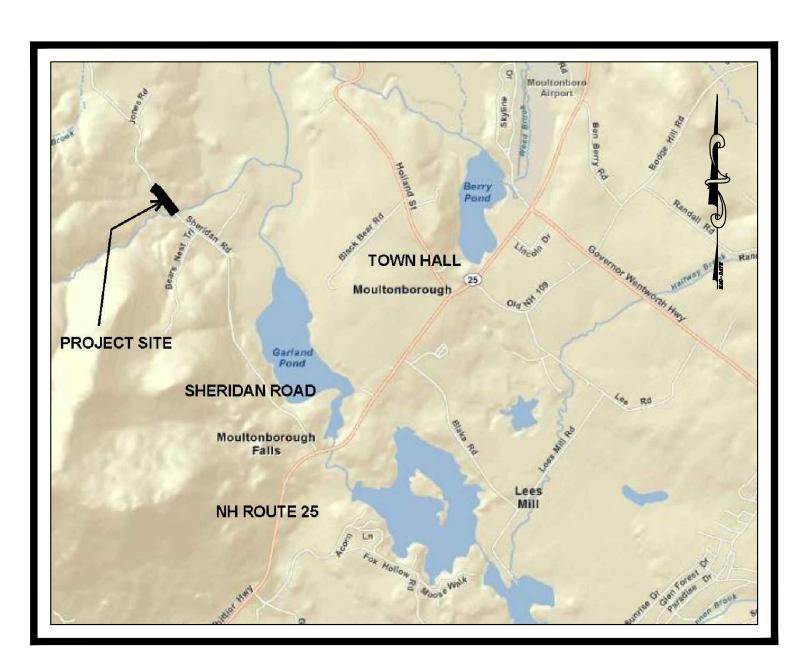

Locus Map Not to Scale

BOARD OF SELECTMEN

Joel R. Mudgett, Chair **Edward J. Charest** Betsey L. Patten Jonathan W. Tolman Russell C. Wakefield

TOWN ADMINISTRATOR Carter Terenzini

ROAD AGENT Scott Kinmond



GENERAL NOTES

- 1. BASE MAP INFORMATION IS PROVIDED BY PROMISED LAND SURVEY, LONDONDERRY, NEW HAMPSHIRE. SURVEY COMPLETED IN NOVEMBER 2010.
- 2. HORIZONTAL DATUM IS NH STATE PLANE NAD83 BASED ON LEICA GPS. THE VERTICAL DATUM IS REFERENCED TO NGVD29 BASED ON LEICA GPS.
- 3. FOR BORING/PROBE LOGS REFER TO SPECIFICATIONS. BORING/PROBE LOCATIONS SHOWN ON DRAWINGS ARE APPROXIMATE
- 4. THE CONTRACTOR SHALL VERIFY ALL RELEVANT ANGLES, LENGTHS, ELEVATIONS, AND INVERTS PRIOR TO CONSTRUCTION.
- 5. THE LOCATION OF EXISTING UTILITIES AND SUBSURFACE STRUCTURES AS SHOWN ON THE DRAWINGS ARE APPROXIMATE ONLY. THE CONTRACTOR SHALL NOTIFY THE ENGINEER AND APPROPRIATE UTILITY AUTHORITY OF ANY DISCREPANCY WITH THE DRAWINGS. NEITHER THE ENGINEER NOR THE OWNER WARRANTS OR GUARANTEES THE CONDITIONS SHOWN ON THE DRAWINGS.
- 6. THE CONTRACTOR SHALL VERIFY THE LOCATION OF ALL SUBSURFACE STRUCTURES AND UTILITIES THROUGH THE APPROPRIATE AGENCY. THE CONTRACTOR SHALL VERIFY THE LOCATION OF ALL EXISTING UTILITIES PRIOR TO ANY EXCAVATION. THE CONTRACTOR SHALL CALL THE DIG-SAFE CENTER (1-888-344-7233) AT LEAST 72 BUSINESS HOURS PRIOR TO ANY EXCAVATION.
- 7. THE CONTRACTOR SHALL COORDINATE ALL CONSTRUCTION ACTIVITY WITH THE VARIOUS AFFECTED UTILITY AUTHORITIES TO PREVENT UNNECESSARY DELAY OF WORK OR INTERRUPTION OF SERVICES.
- 8. THE CONTRACTOR SHALL BE RESPONSIBLE FOR PROTECTING AND SUPPORTING ALL UTILITIES DURING CONSTRUCTION AND FOR COORDINATING SUCH ACTIVITY WITH THE APPROPRIATE UTILITY AUTHORITY. UTILITIES DESTROYED OR DAMAGED BY THE CONTRACTOR SHALL BE REPAIRED OR REPLACED AS DIRECTED BY THE UTILITY AUTHORITY AT NO ADDITIONAL COST TO THE OWNER.
- 9. THE CONTRACTOR SHALL MAINTAIN TRAFFIC IN A SAFE MANNER AT ALL TIMES DURING CONSTRUCTION AND IN ACCORDANCE WITH THE MANUAL ON UNIFORM TRAFFIC CONTROL DEVICES (MUTCD).
- 10. THE CONTRACTOR SHALL INSTALL AND MAINTAIN TEMPORARY FACILITIES AS NEEDED TO AVOID SERVICE DISRUPTIONS. THE CONTRACTOR SHALL SUBMIT A PLAN TO BE REVIEWED BY THE ENGINEER FOR MAINTAINING SERVICE TO BUILDINGS AFFECTED BY THE CONSTRUCTION. THE CONTRACTOR SHALL BE RESPONSIBLE FOR NOTIFYING CUSTOMERS OF SERVICE DISRUPTIONS. NO DISRUPTION OF SERVICE SHALL BE BEFORE 9:00 AM OR AFTER 3:00 PM.
- 11. THE CONTRACTOR SHALL CONFINE ALL OPERATIONS AND ACTIVITIES FOR CONSTRUCTION PURPOSES WITHIN THE EXISTING RIGHT—OF—WAY, TEMPORARY EASEMENTS OR IN STAGING/STOCKPILE AREAS APPROVED BY THE OWNER. THE CONTRACTOR SHALL LOCATE STAGING AREAS THROUGH AGREEMENTS WITH AFFECTED PROPERTY OWNERS, OR PROVIDE ALTERNATE MEANS TO STORE MATERIAL AT THE WORK AREA AS REQUIRED.
- 12. DURING NON-WORKING HOURS, THE CONTRACTOR SHALL SECURE ALL EQUIPMENT AND MATERIALS WITHIN THE LIMITS OF WORK.
- 13. THE CONTRACTOR SHALL BE RESPONSIBLE FOR ANY DAMAGE TO EXISTING PAVEMENT, ROADWAYS, SIGNS, CURBS, SIDEWALKS, DRIVEWAYS, MAILBOXES, FENCES, PLANTINGS OR OTHER PHYSICAL FEATURES CAUSED BY THE CONTRACTOR'S ACTIVITIES AND SHALL REPAIR THEM AT NO ADDITIONAL COST TO THE OWNER. ALL AREAS BEYOND THE LIMITS OF CONSTRUCTION WHICH ARE DISTURBED BY THE CONTRACTOR SHALL BE RESTORED TO THEIR ORIGINAL CONDITION AT NO ADDITIONAL COST TO THE OWNER.
- 14. THE CONTRACTOR SHALL TAKE PRECAUTIONS DURING CONSTRUCTION TO MINIMIZE THE AMOUNT OF DEBRIS THAT COLLECTS IN CATCH BASINS, CULVERTS AND MANHOLES. THE CONTRACTOR SHALL CLEAN ALL CATCH BASINS, CULVERTS AND MANHOLES AFFECTED BY CONSTRUCTION IN ORDER TO MAINTAIN AN OPERATING SYSTEM.
- 15. ALL WORK SHALL BE DONE IN ACCORDANCE WITH ALL APPLICABLE LOCAL, STATE AND FEDERAL CODES. THE CONTRACTOR SHALL BE RESPONSIBLE FOR OBTAINING ALL REQUIRED PERMITS FROM APPLICABLE GOVERNMENTAL AGENCIES, INCLUDING THE OWNER, PRIOR TO THE START OF ANY CONSTRUCTION.
- 16. THE CONTRACTOR IS REQUIRED TO PROVIDE ADEQUATE SHORING FOR THE SOIL CONDITIONS AND DEPTHS ENCOUNTERED DURING CONSTRUCTION.
- 17. IN THE EVENT THE CONTRACTOR ENCOUNTERS EXISTING MATERIAL REASONABLY BELIEVED TO BE HAZARDOUS WHICH HAS NOT BEEN RENDERED HARMLESS, THE CONTRACTOR SHALL IMMEDIATELY STOP WORK IN THE AFFECTED AREA AND REPORT THE CONDITION TO THE OWNER AND ENGINEER. WORK IN THE AFFECTED AREA SHALL NOT RESUME UNTIL WRITTEN VERIFICATION BY THE OWNER THAT THE MATERIAL HAS BEEN REMOVED OR OTHERWISE BEEN RENDERED HARMLESS.
- 18. THE CONTRACTOR AND ALL SUBCONTRACTORS SHALL FAMILIARIZE THEMSELVES WITH THE CONTRACT DOCUMENTS. ALL DRAWINGS OF ANY PARTICULAR TRADE SHALL BE USED IN CONJUNCTION WITH DRAWINGS OF ALL OTHER TRADES TO COORDINATE THE CONSTRUCTION. ANY DISCREPANCIES SHALL BE BROUGHT TO THE ATTENTION OF THE ENGINEER BEFORE PROCEEDING WITH THE AFFECTED WORK. ANY PROPOSED CHANGES, VARIATIONS, OR SUBSTITUTIONS MUST BE REVIEWED AND ACCEPTED BY THE ENGINEER PRIOR TO IMPLEMENTATION.

LEGEND

EXISTING

ELECTRIC METER

TEMPORARY BENCH MARK

FLAG POLE

MAIL BOX

TV ANTENNA

CATCH BASIN

DROP INLET

——— D —— DRAIN LINE

FIRE HYDRANT

LP GAS TANK

UOG UNDERGROUND LP GAS TANK

SEWER MANHOLE

s-- SEWER LINE

TELEPHONE MANHOLE

₩ WATER SHUTOFF

WATER VALVE BOX

UTILITY POLE

WATER GATE

— w—— w—— WATER LINE

-GUY POLE

∠ GUY WIRE

-----OHU ------ OVERHEAD UTILITY LINES (ELECTRIC, TELEPHONE, CABLE)

STONE RETAINING WALL

CONCRETE RETAINING WALL

GRANITE RETAINING WALL

BRICK WALKWAY

CONCRETE WALKWAY

STONE WALKWAY

LEDGE OUTCROP

WOOD FENCE

TREE/SHRUB LINE



CONIFEROUS TREES

DECIDUOUS TREES

⊕ B−1

BORING LOCATION AND DESIGNATION

<u>PROPOSED</u>

EDGE OF PAVEMENT

LIMIT OF SLOPE

DRAIN LINE


GUARDRAIL

CATCH BASIN

FLARED END SECTION (FES)

F 590.2 SPOT ELEVATION

NUMBER	DATE	BY	DESCRIPTION

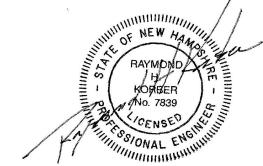



PO BOX 898 MANCHESTER, NH 03105 TEL: (603) 413-6550

www.kvpllc.com

DATE:	07-12-12	
SCALE:	AS NOTED	
DESIGNED BY:	RHK	
DRAWN BY:	NMT	
CHECKED BY:	RHK	

RHK


APPROVED BY:

2012 ROAD PROGRAM - SHERIDAN ROAD MOULTONBOROUGH, NEW HAMPSHIRE


GENERAL NOTES AND LEGEND

SHEET NO.


SHEET 1 OF 8

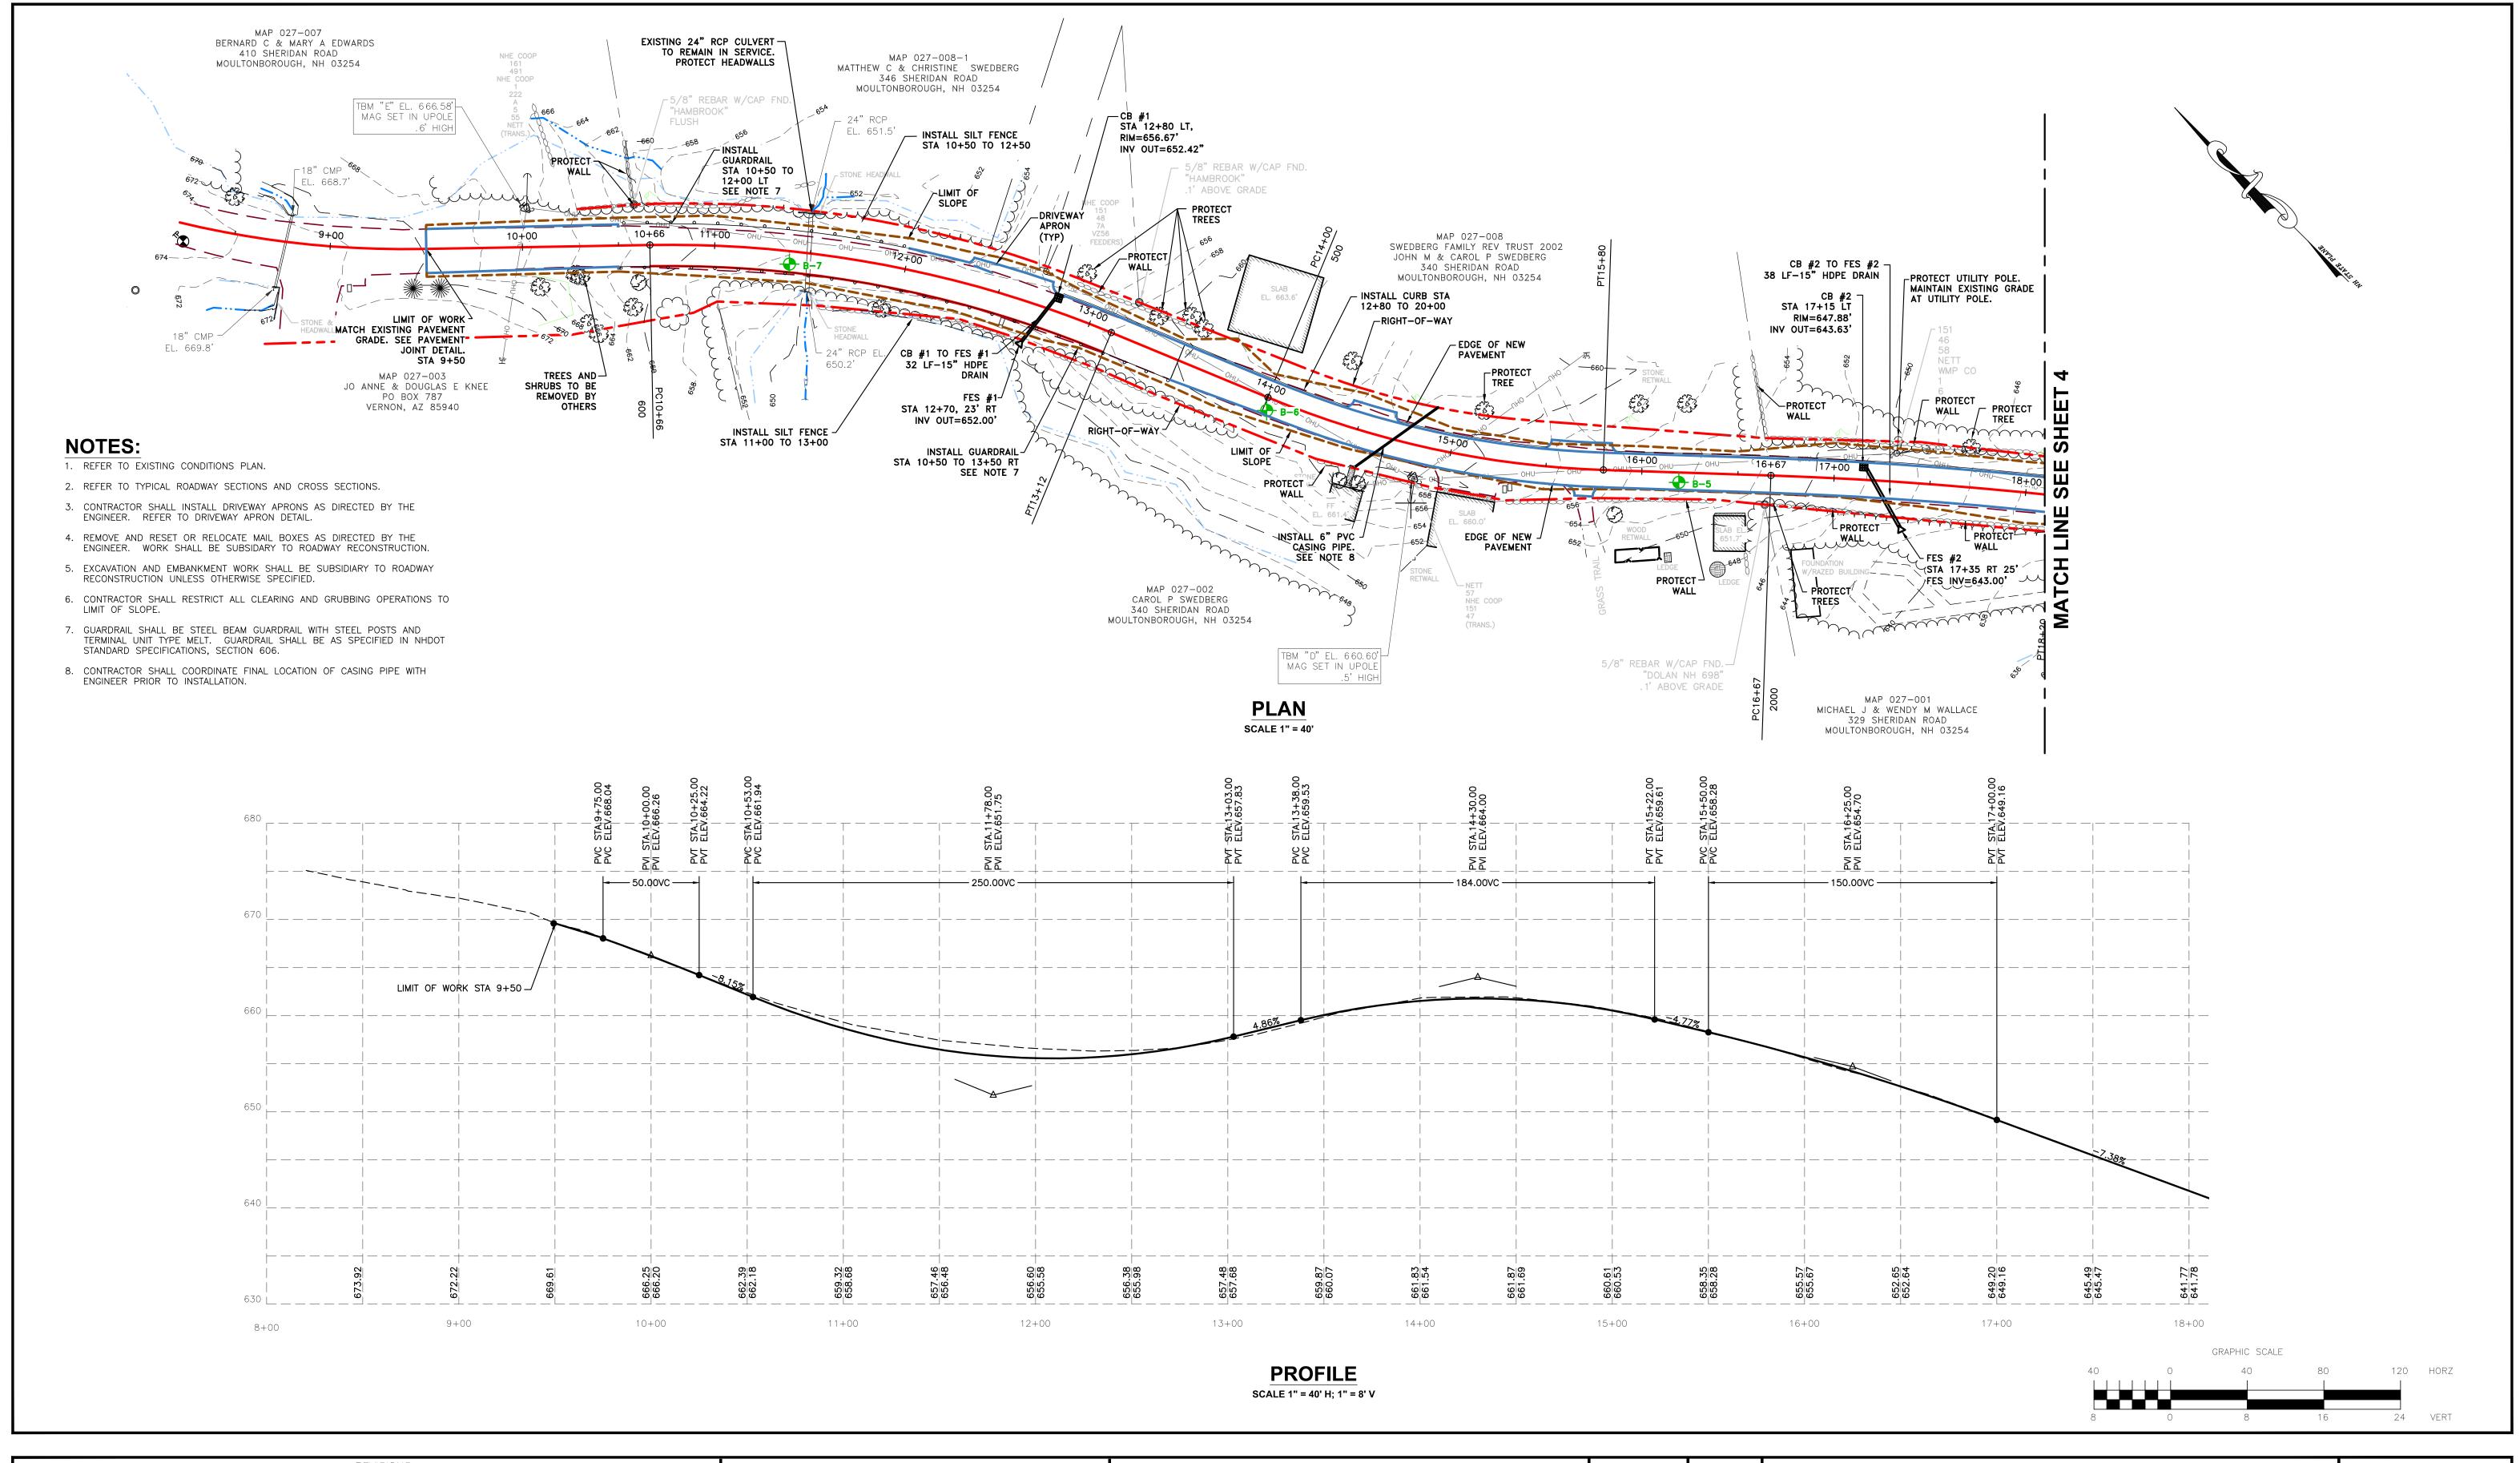


NU	JMBER DATE BY DESCRIPTION	OF NEW HAMAIN			DATE: SCALE:	07-12-12 AS NOTED	2012 ROAD PROGRAM - SHERIDAN ROAD	SHEET NO.
		RAYMOND ARE	KV Partners	PO BOX 7721 PO BOX 432 GILFORD, NH 03247 NEW BOSTON, NH 03070	DESIGNED BY:	RGR	MOULTONBOROUGH, NEW HAMPSHIRE	. 2
<u> </u>		No. 7839	CONSULTING ENGINEERS	TEL: (603) 513-1909 TEL: (603) 413-6550	DRAWN BY:	NMT	PLAN AND PROFILE	
		CENSED WELL		www.kvpllc.com	CHECKED BY:	RHK		SHEET 2 OF 8
		WAL EMMINISTRA			APPROVED BY:	RHK	STA 9+50 TO 18+00	SHEET Z OF 0

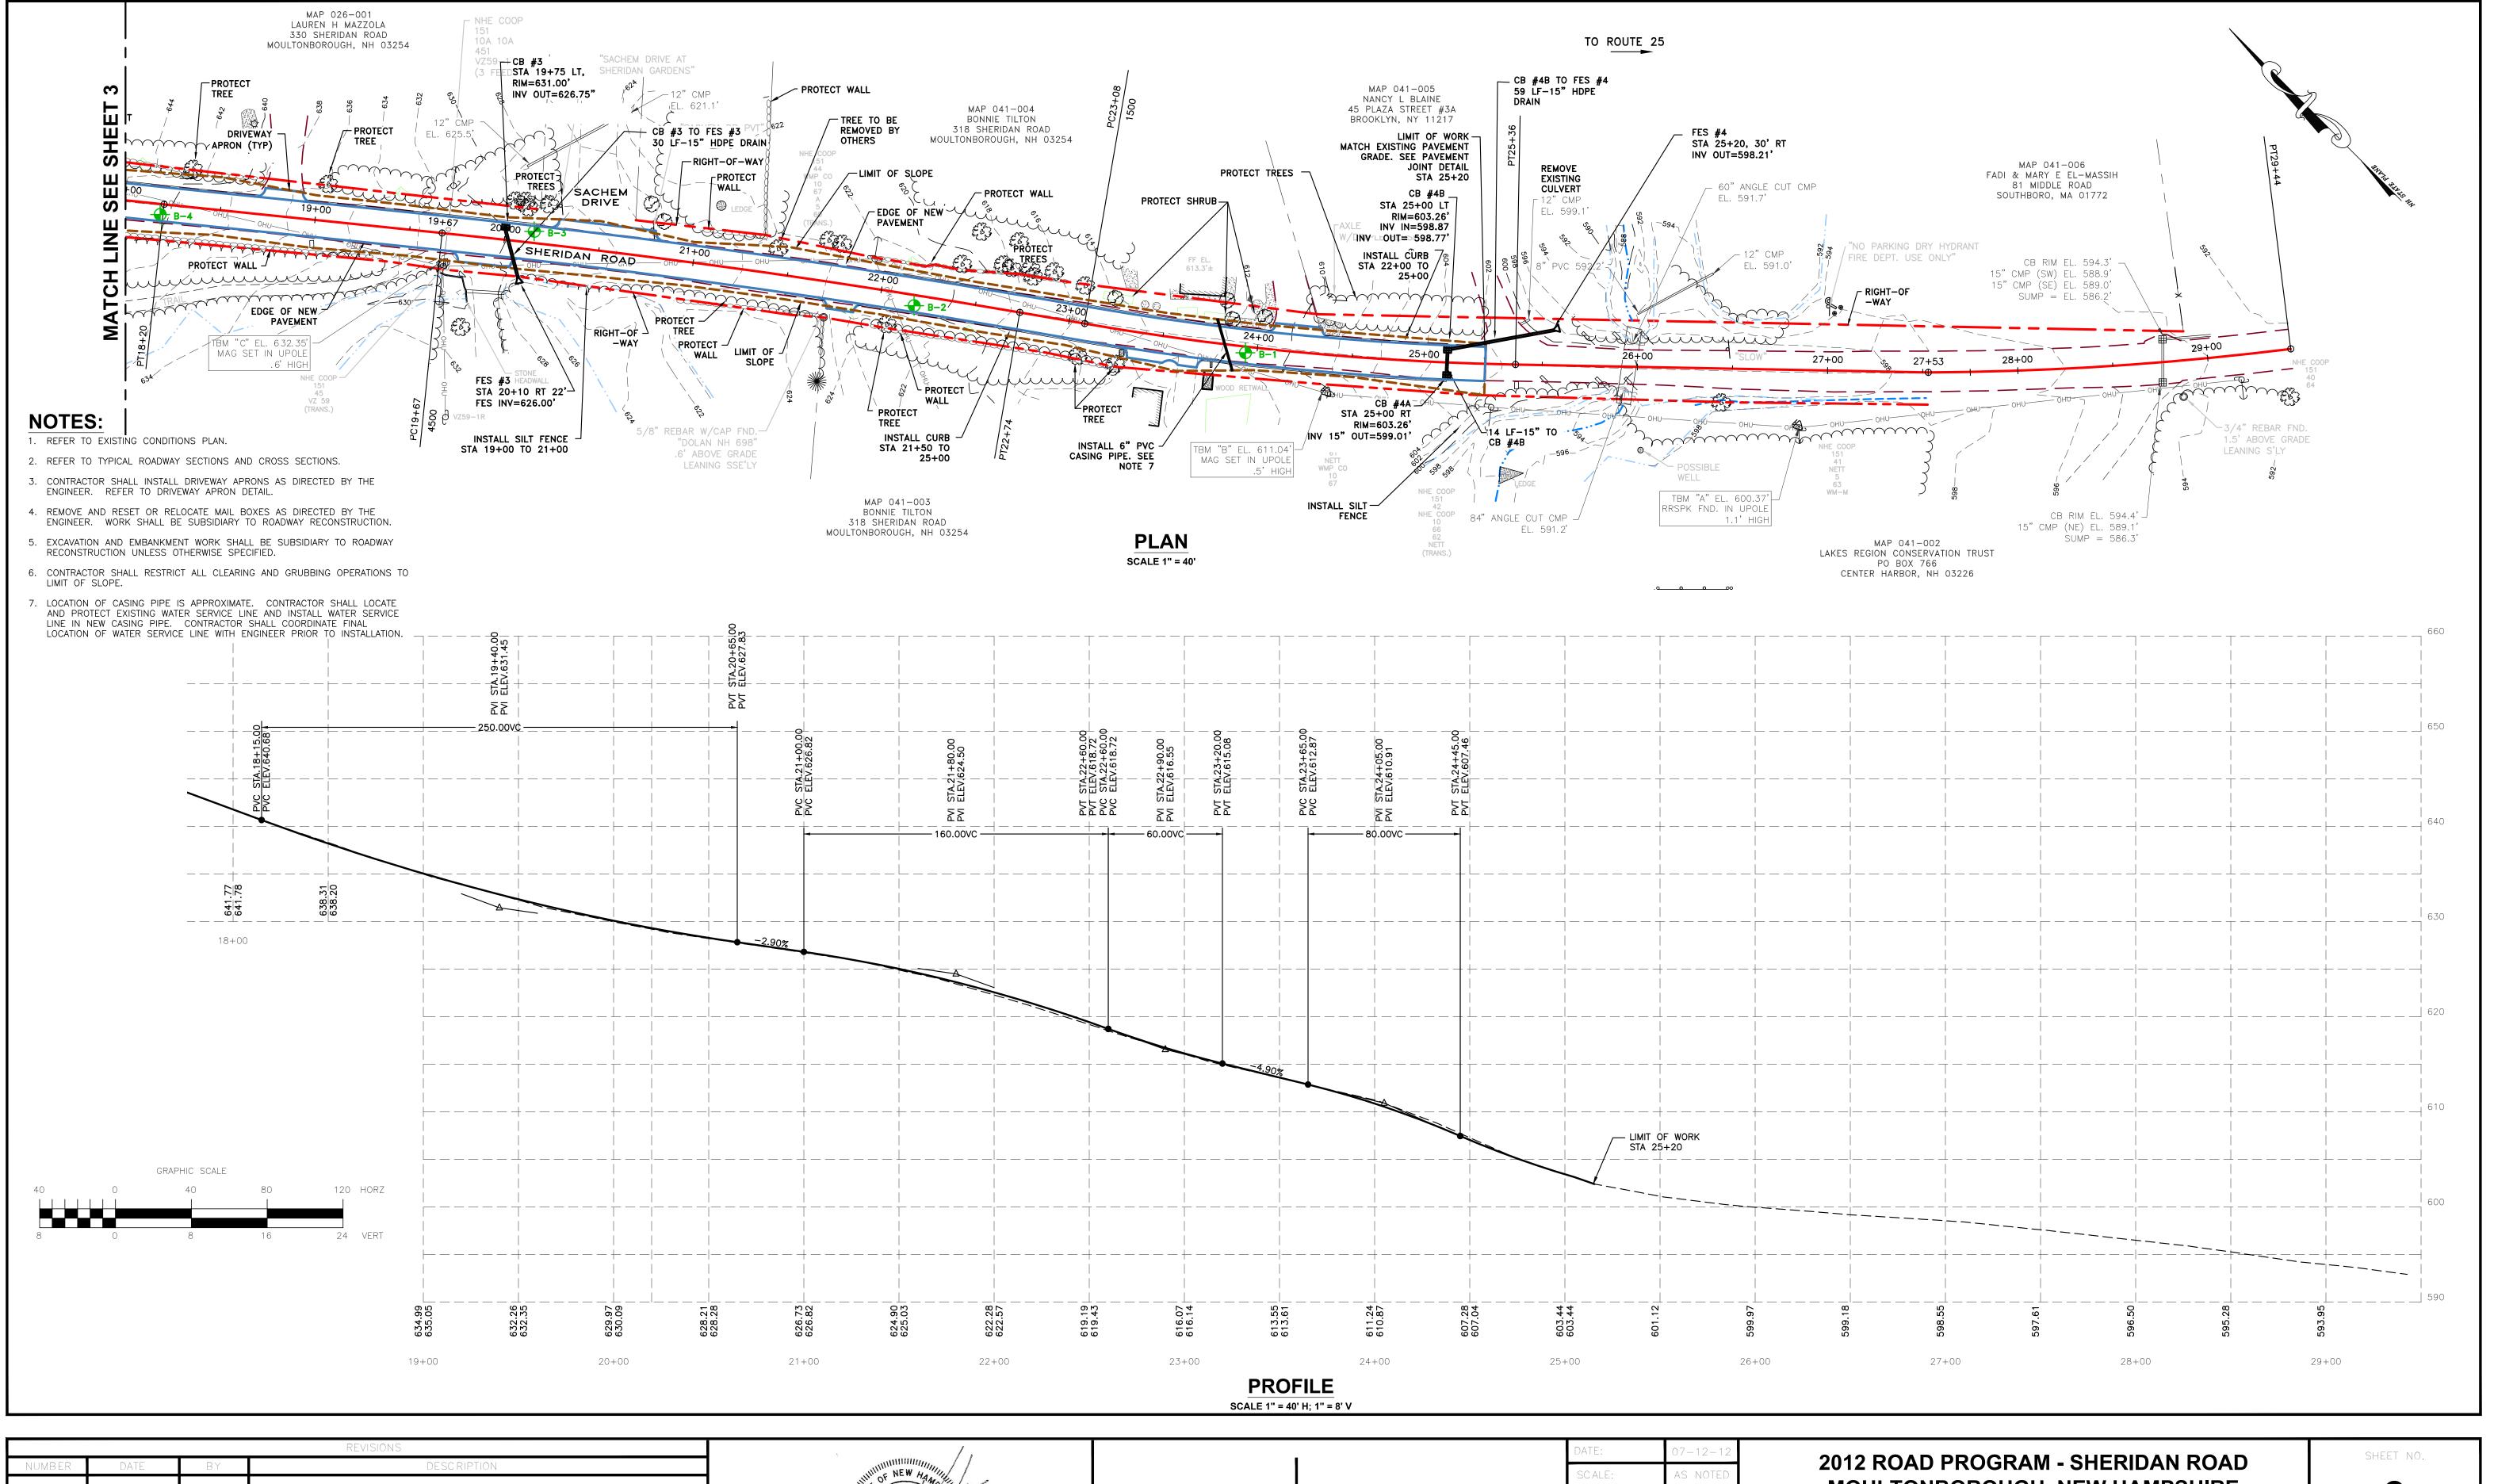


	D 1	RAYMOND A RAYMOND	KV Partners	PO BOX 7721 PO BOX 432 GILFORD. NH 03247 NEW BOSTON. NH 0307	SCALE: DESIGNED BY:	AS NOTED RGR	2012 ROAD PROGRAM - SHERIDAN ROAD MOULTONBOROUGH, NEW HAMPSHIRE	3
		KORBER I	CONSULTING ENGINEERS	TEL: (603) 513-1909 TEL: (603) 413-6550	DRAWN BY:	NMT	PLAN AND PROFILE	
		TOENSED IN THE TOP OF THE PARTY		www.kvpllc.com	CHECKED BY:	RHK		CHEET 2 OF 0
		- WINDOWAL ENGINEERING		1	APPROVED BY:	RHK	STA 18+00 TO 25+00	SHEET 3 OF 8

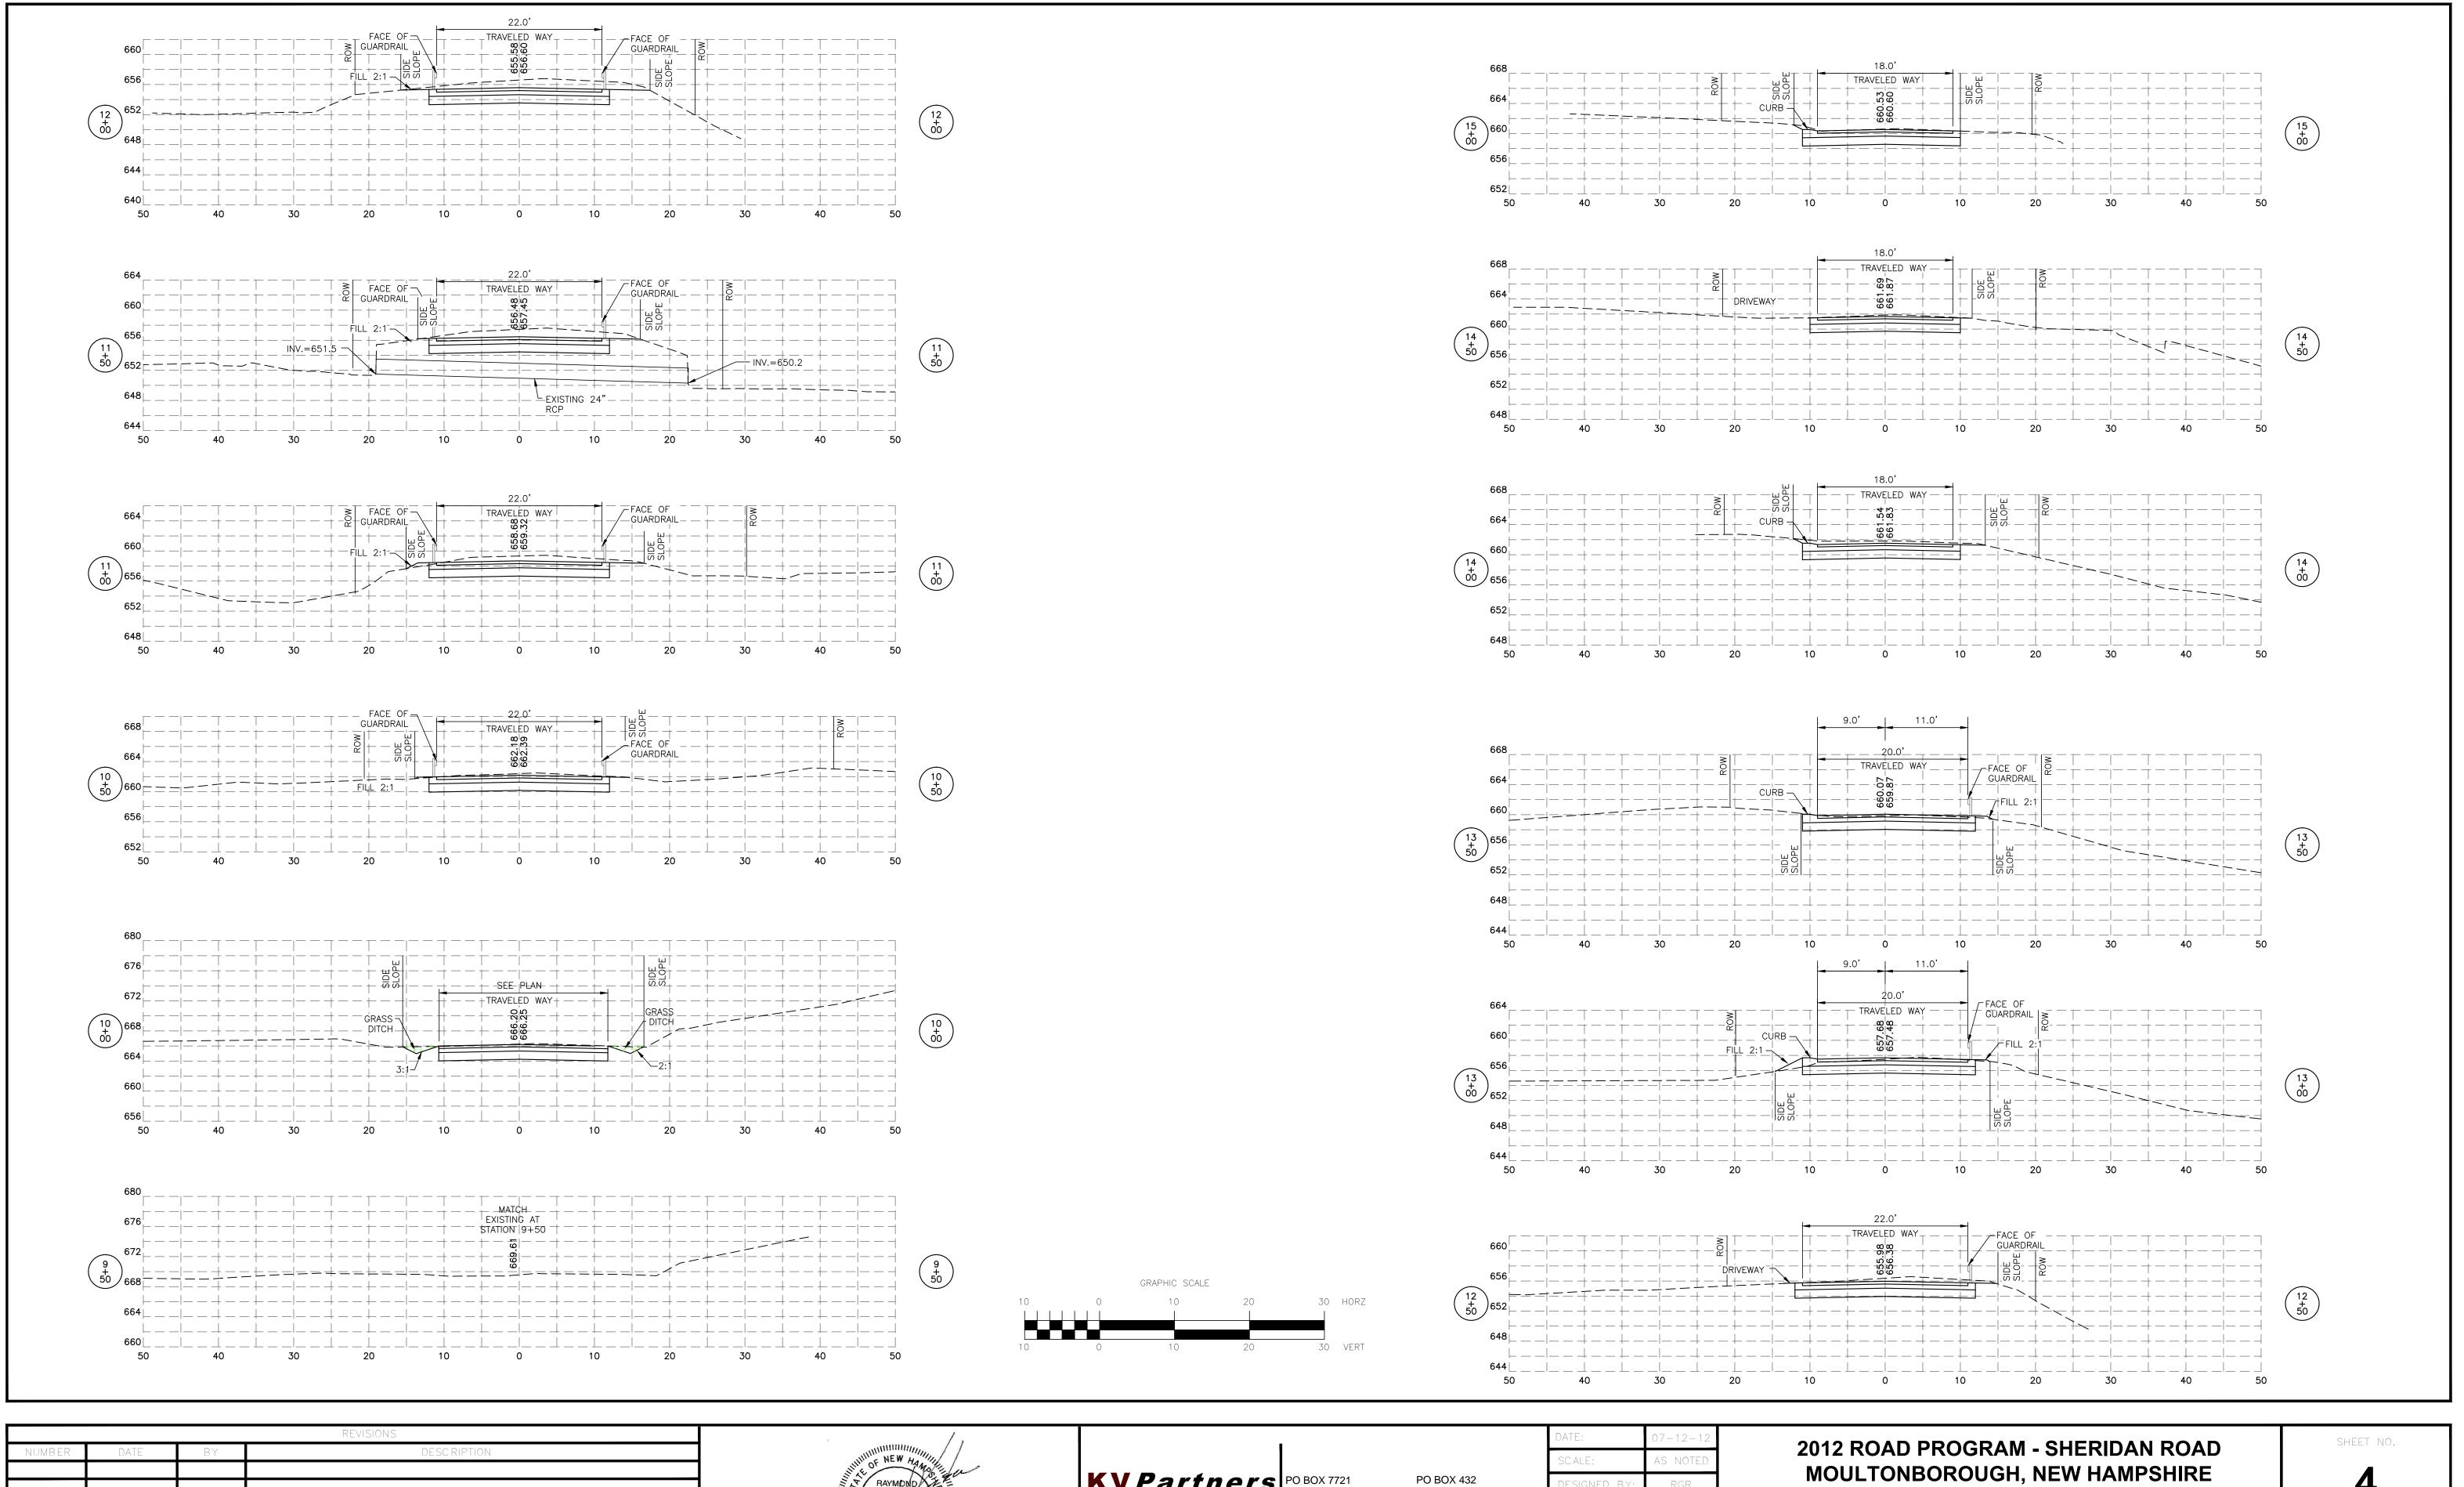


			REVISIONS			DATE:	07-12-12		SHEET NO.
NUMBER	R DATE	ВҮ	DESC RIPTION	WINDE NEW HOUSE		SCALE:	AS NOTED	2012 ROAD PROGRAM - SHERIDAN ROAD	SHEET INO.
				RAYMOND A	KVPartners PO BOX 7721 PO BOX 432	DESIGNED BY:	RGR	MOULTONBOROUGH, NEW HAMPSHIRE	4
				-	GILFORD, NH 03247 CONSULTING ENGINEERS GILFORD, NH 03247 TEL: (603) 513-1909 TEL: (603) 413-6550	DRAWN BY:	NMT		† • • • • • • • • • • • • • • • • • • •
				JAPANSEO HALLING	www.kvpllc.com	CHECKED BY:	RHK	CROSS SECTIONS	
				- MINIMANIAN ENGLISH		APPROVED BY:	RHK	STA 9+50 TO 15+00	SHEET 4 OF 8

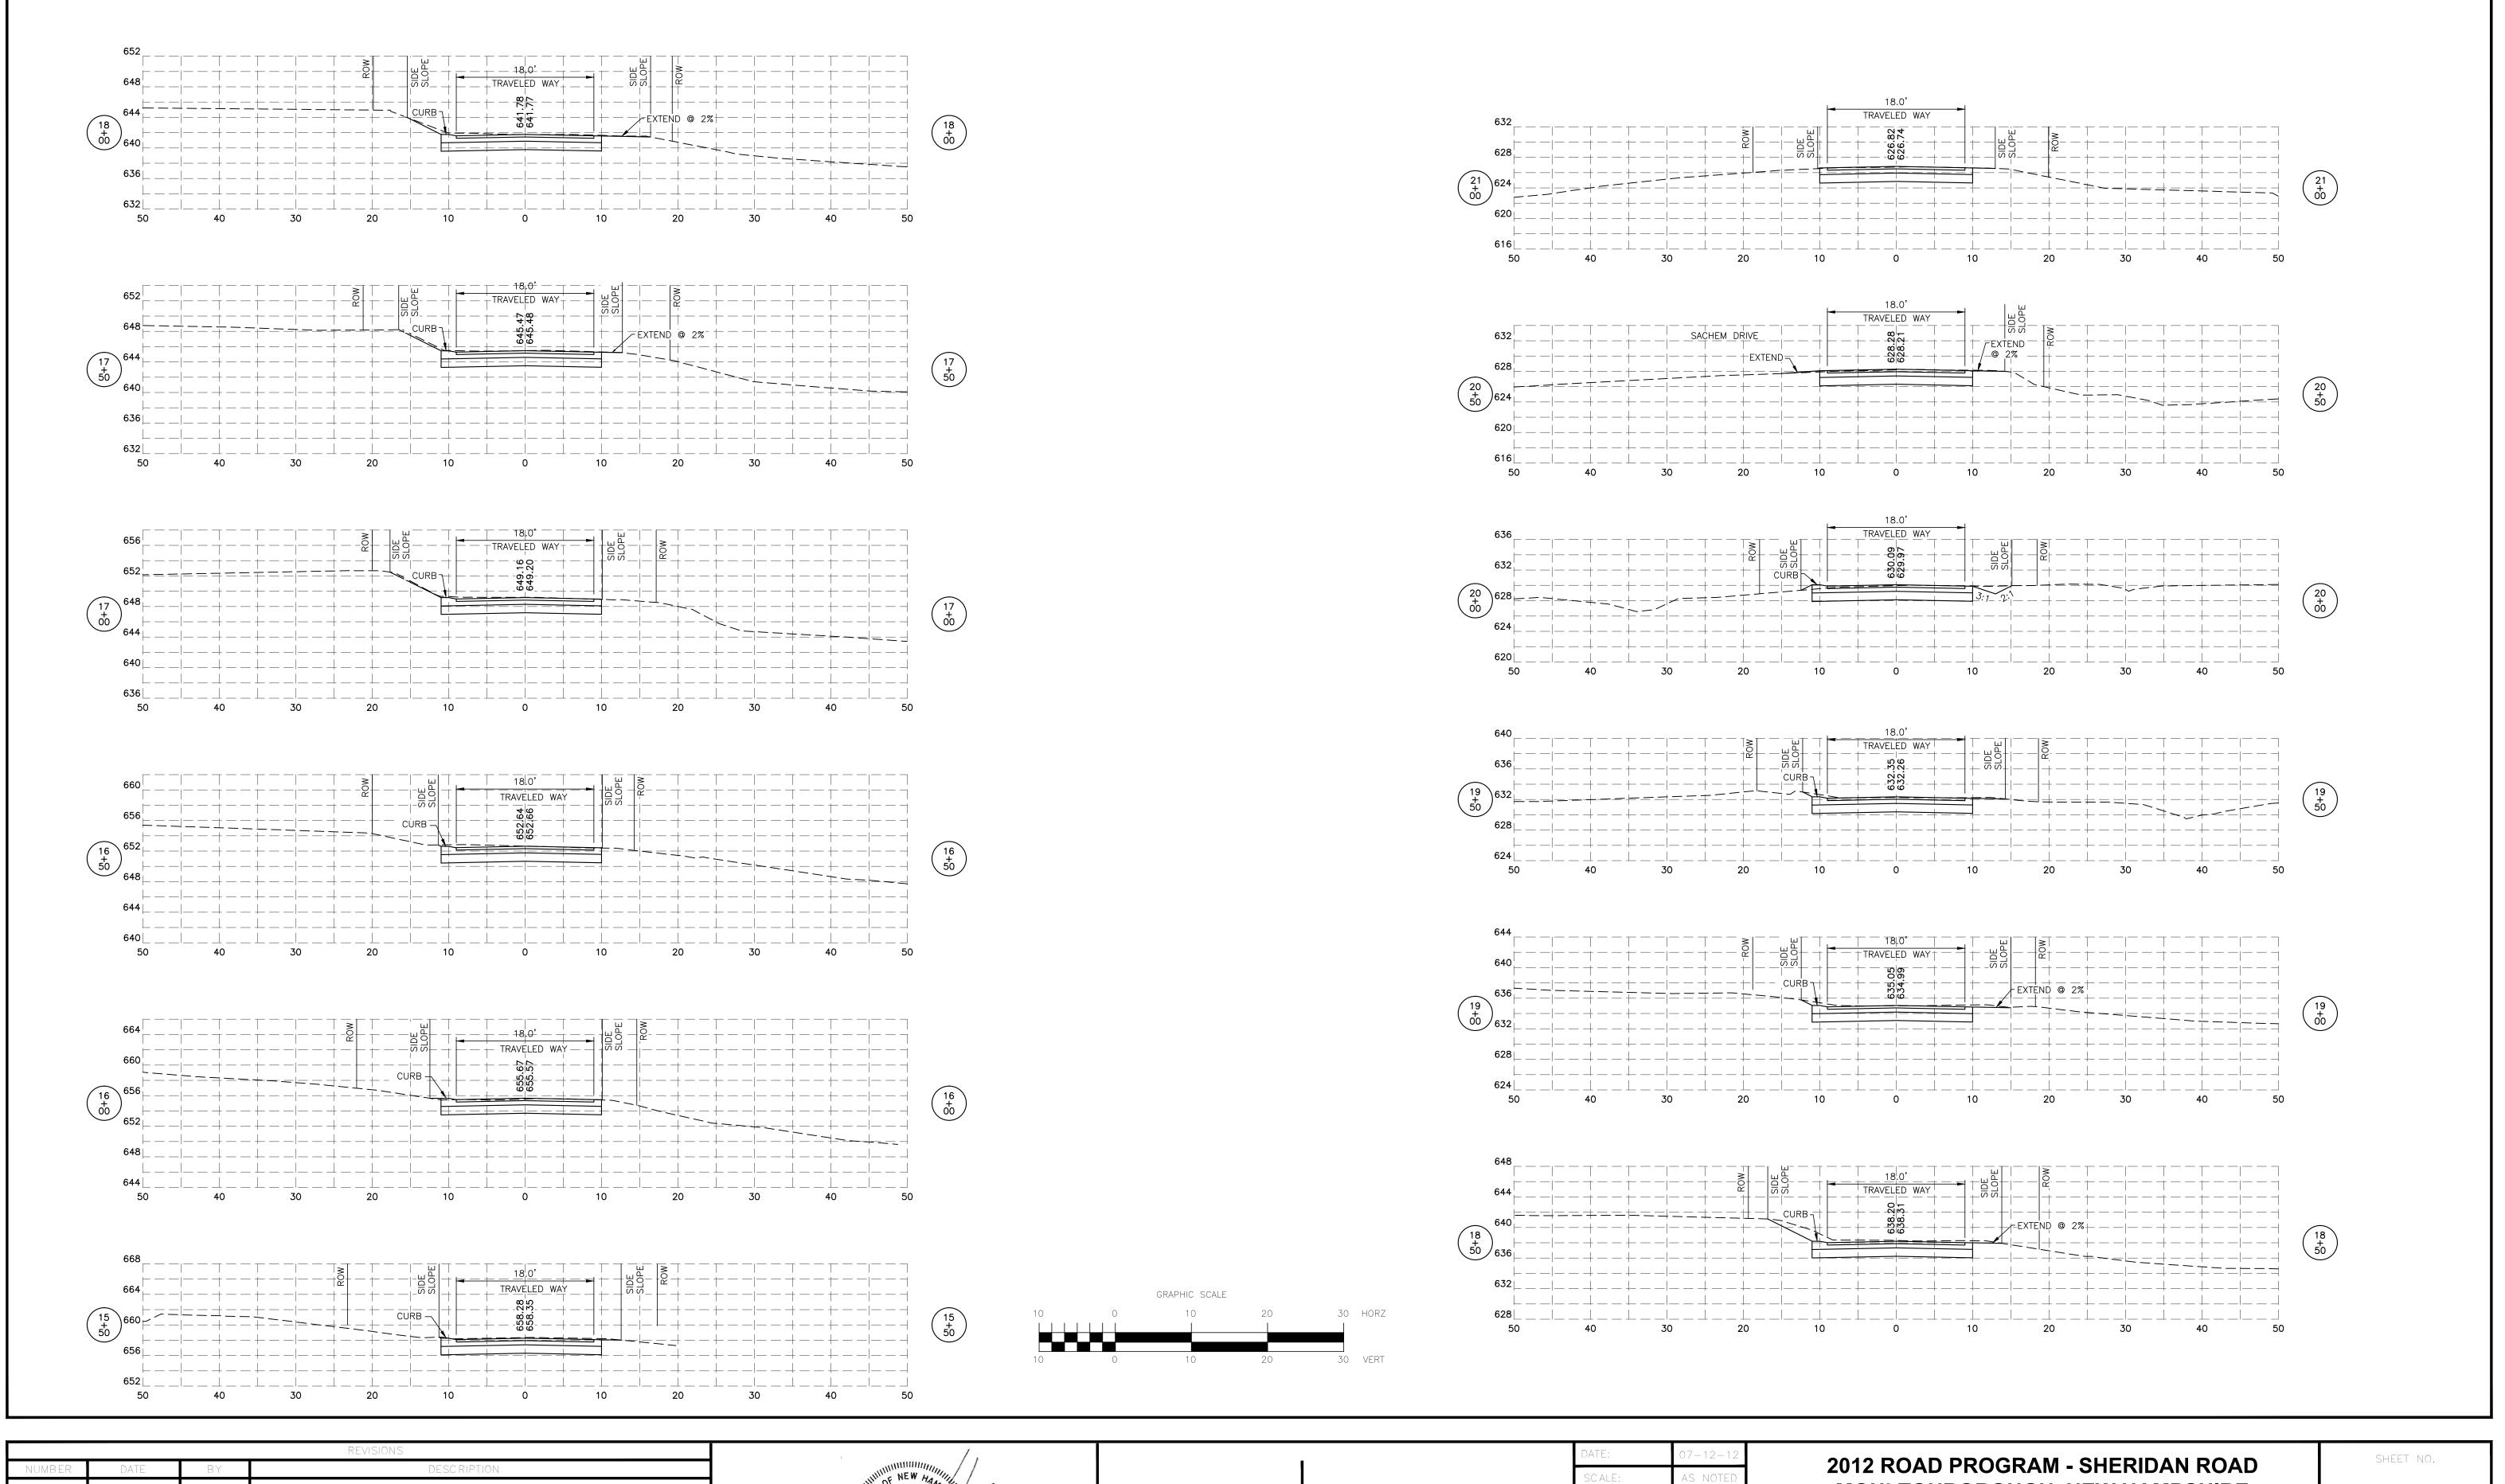


			REVISIONS	,		_	DATE:	07-12-12		SHEET NO.
NUMBER	DATE	BY	DESC RIPTION	WEN HOUSE			SCALE:	AS NOTED	2012 ROAD PROGRAM - SHERIDAN ROAD	31,221 110.
				RAYMOND TO	KV Partners	PO BOX 7721 PO BOX 432	DESIGNED BY:	RGR	MOULTONBOROUGH, NEW HAMPSHIRE	5
				KORRER I	CONSULTING ENGINEERS	GILFORD, NH 03247 NEW BOSTON, NH 03070 TEL: (603) 513-1909 TEL: (603) 413-6550	DRAWN BY:	NMT		1
				CENSED THE TOTAL PROPERTY OF THE PROPERTY OF T		www.kvpllc.com	CHECKED BY:	RHK	CROSS SECTIONS	
				- MINIMARIAN ENGLISH			APPROVED BY:	RHK	STA 15+50 TO 21+00	SHEET 5 OF 8

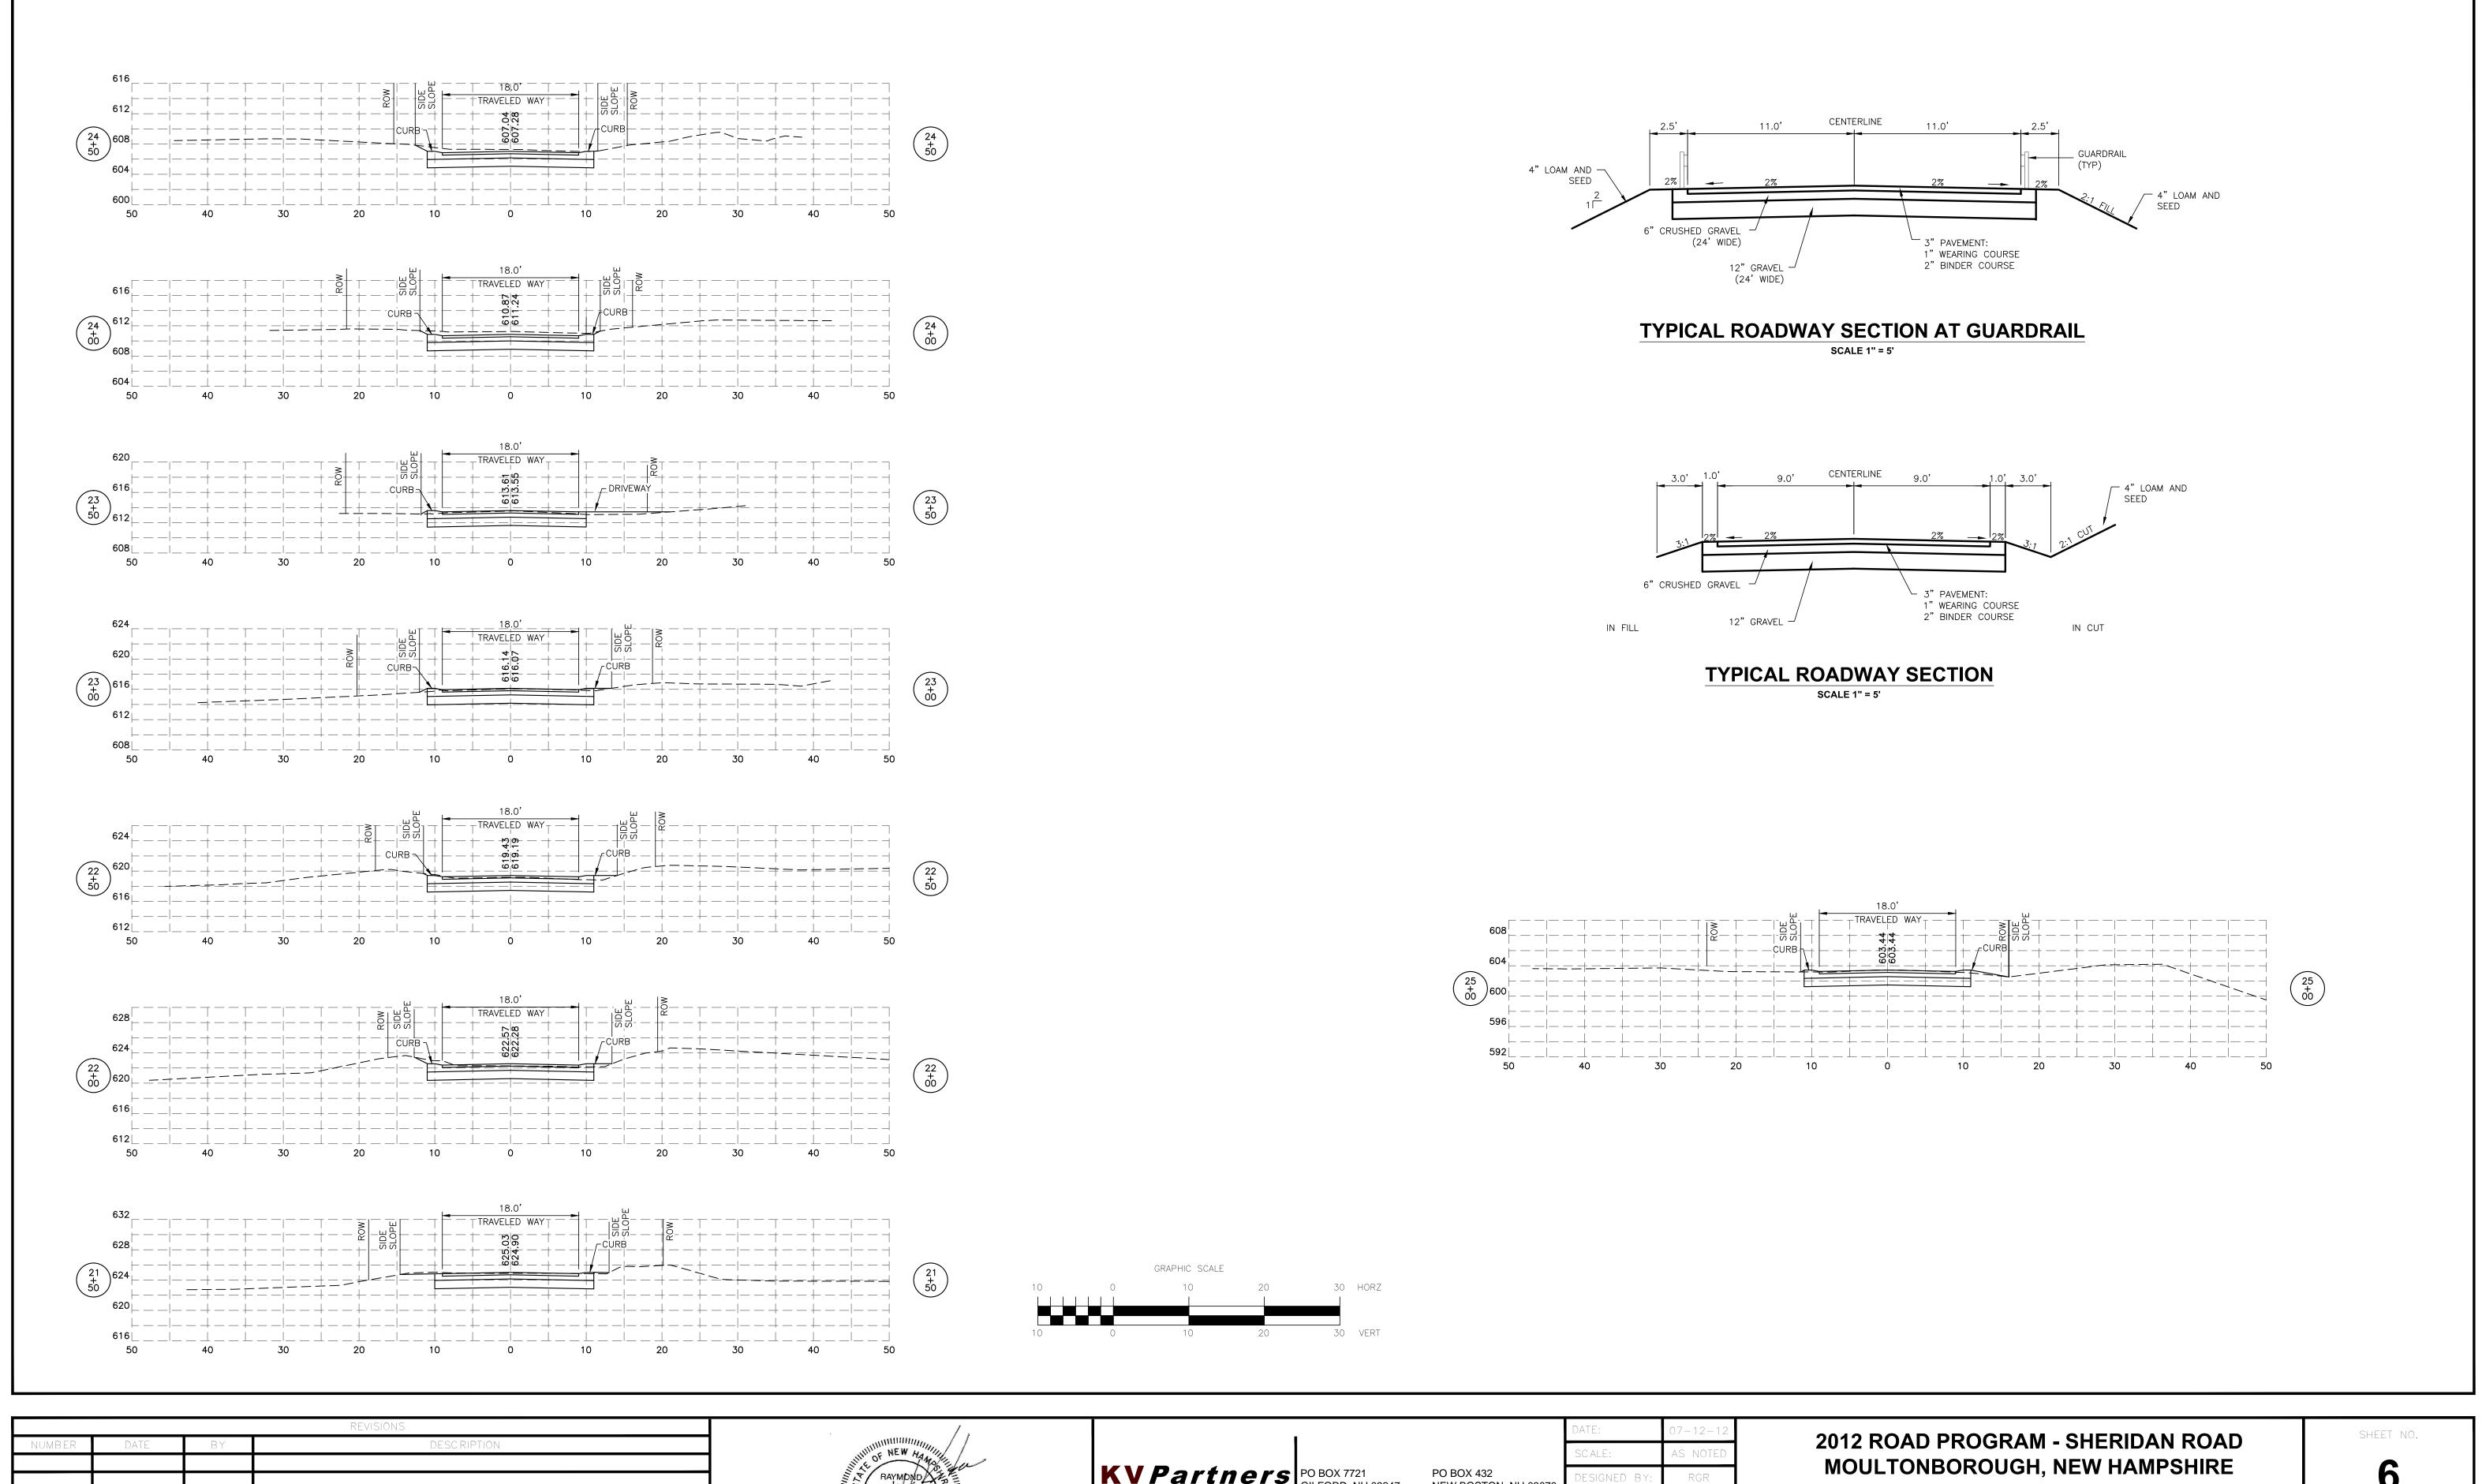


NUMBER	DATE	ВҮ	DESCRIPTION	RAYMOND RAYMOND	KV Partners	PO BOX 7721 PO BOX 432	SCALE: DESIGNED BY:	AS NOTED	2012 ROAD PROGRAM - SHERIDAN ROAD MOULTONBOROUGH, NEW HAMPSHIRE	SHEET NO.
				HORRER HORRER	CONSULTING ENGINEERS	GILFORD, NH 03247 NEW BOSTON, NH 03070 TEL: (603) 513-1909 TEL: (603) 413-6550	DRAWN BY:	NMT	CROSS SECTIONS STA 21+50 TO 25+00	
				A THE CONSESSION OF THE PROPERTY OF THE PROPER		www.kvpllc.com	CHECKED BY:	RHK RHK		SHEET 6 OF 8

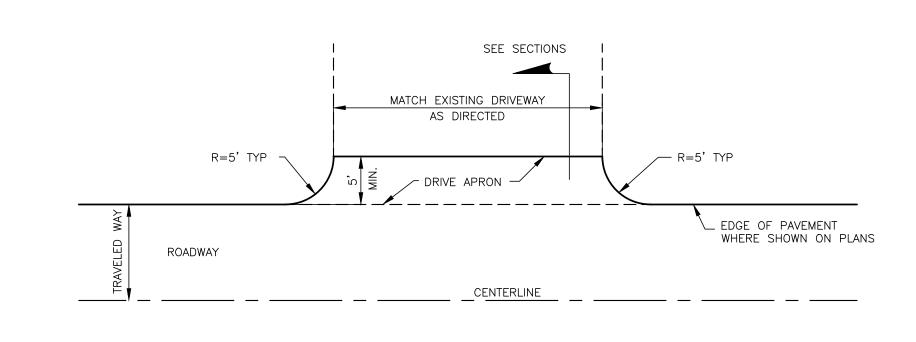

PLAN

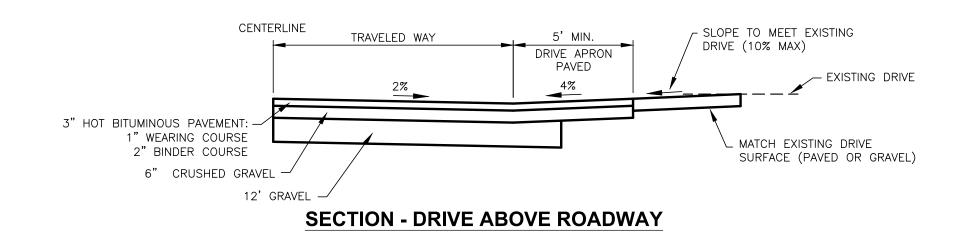

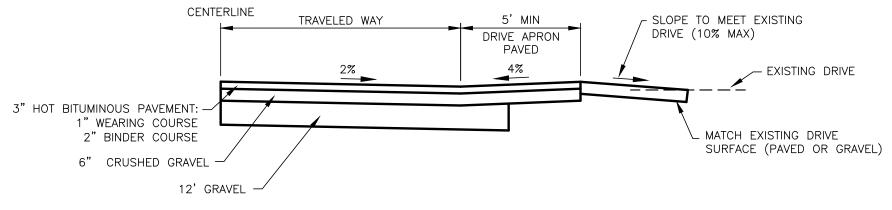


SECTION - DRIVE BELOW ROADWAY

NOTES:


 CONTRACTOR SHALL COORDINATE WITH ENGINEER ON DRIVEWAY APRON WIDTH AND TRANSITION REQUIREMENT PRIOR TO COMMENCEMENT OF WORK.

DRIVEWAY APRON DETAIL NOT TO SCALE

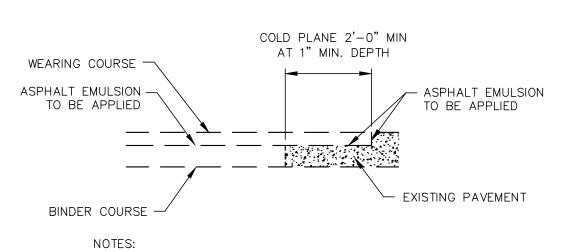

 CONTRACTOR SHALL COORDINATE WITH ENGINEER PRIOR TO COMMENCEMENT OF WORK REGARDING JOINT LOCATION.

PAVEMENT JOINT DETAIL NOT TO SCALE

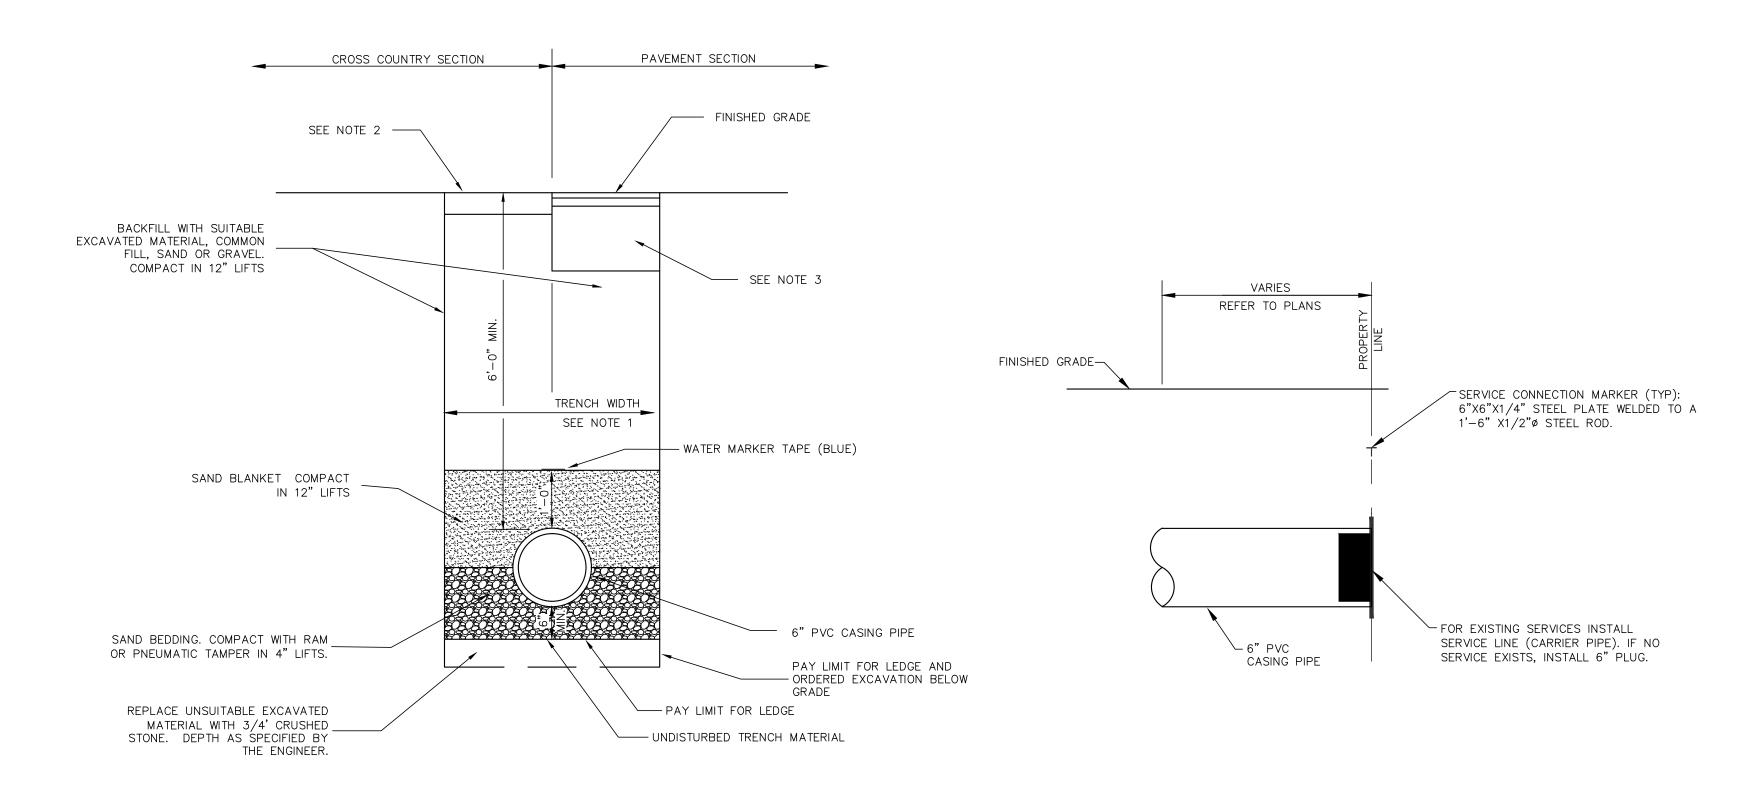


NOTE

1. ALLOWABLE TRENCH WIDTH:

- a. FOR PIPE LESS THAN OR EQUAL TO 12 INCHES IN DIAMETER, THE ALLOWABLE TRENCH WIDTH AT PLANE 12 INCHES ABOVE PIPE SHALL BE NO MORE THAN 36 INCHES.
- b. FOR PIPE GREATER THAN 12 INCHES IN DIAMETER THE ALLOWABLE TRENCH WIDTH SHALL BE EQUAL TO THE PIPE OUTSIDE DIAMETER PLUS 24 INCHES
- 2. WHERE GRASS OCCURS, LOAM AND SEED ALL DISTURBED AREAS TO A MINIMUM DEPTH OF 4 INCHES UNLESS OTHERWISE NOTED. WHERE NO GRASS OCCURS, MATCH EXISTING MATERIALS AND DEPTHS OR PLACE A MINIMUM OF 6 INCHES OF GRAVEL, WHICHEVER IS GREATER.
- 3. REFER TO TYPICAL ROADWAY SECTIONS.
- 4. BEDDING SHALL BE WRAPPED IN FILTER FABRIC IN LOCATIONS WHERE SOIL IS CONSIDERED UNSUITABLE BY THE ENGINEER.


CASING PIPE TRENCH DETAIL

NOT TO SCALE

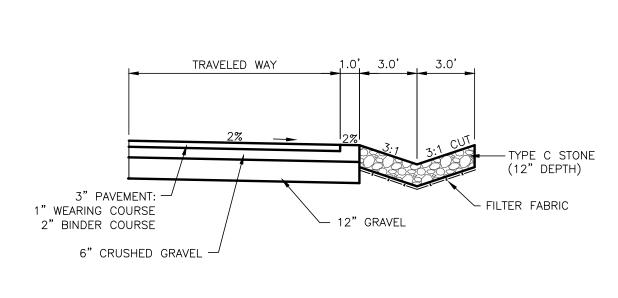

STONE LINED SWALE DETAIL


SCALE 1" = 5'

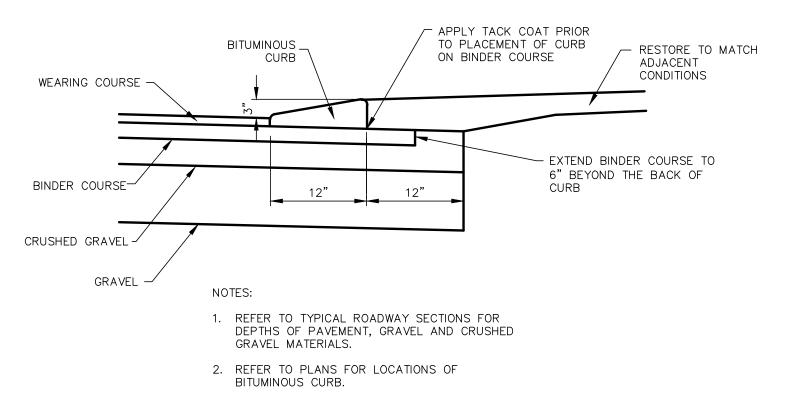

BITUMINOUS CURB DETAIL

NOT TO SCALE

			REVISIONS			DATE: 07-12-12		SHEET NO.
NUMBER	DATE	ВҮ	DESCRIPTION	WILLIAM HOUSE		SCALE: AS NOTED	2012 ROAD PROGRAM - SHERIDAN ROAD	SHEET INO.
				RAYMOND A	KVPartners PO BOX 7721 PO BOX 432	DESIGNED BY: RGR	MOULTONBOROUGH, NEW HAMPSHIRE	7
				KORBER I	CONSULTING ENGINEERS TEL: (603) 513-1909 TEL: (603) 413-6550	DRAWN BY: NMT		1 '
				THE COENSED WITH	www.kvpllc.com	CHECKED BY: RHK	ROADWAY AND MISCELLANEOUS DETAILS	011557 7 05 0
				MINION ONAL ENGINEER		APPROVED BY: RHK		SHEET 7 OF 8

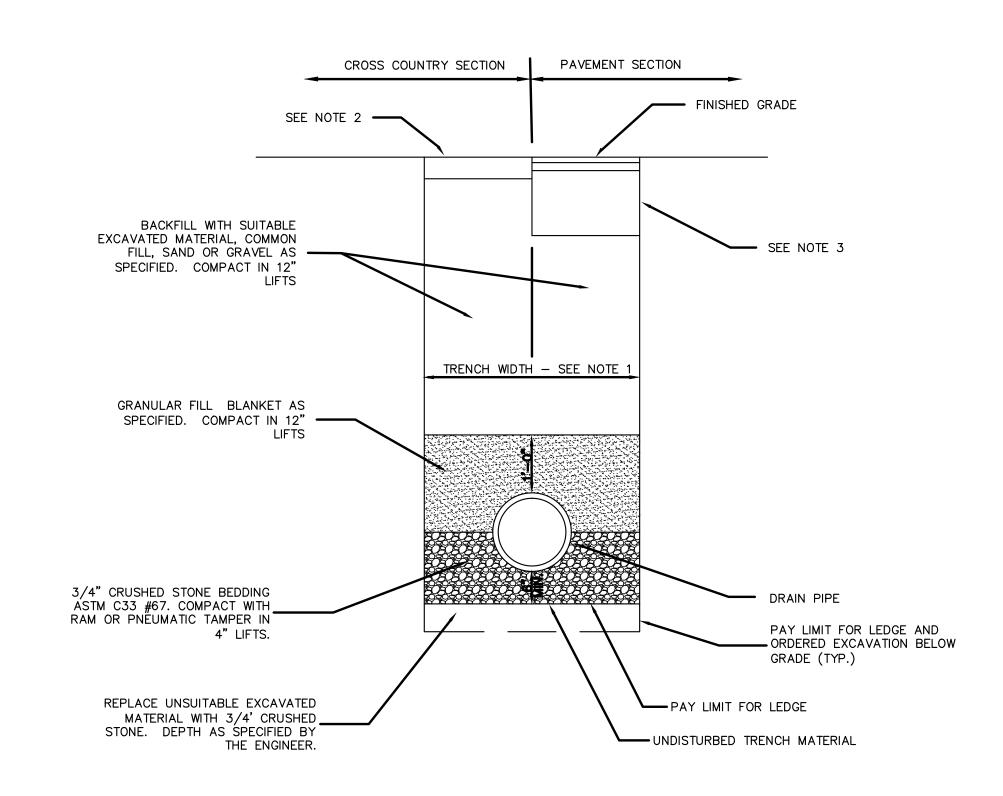


NOTES

- 1. MAXIMUM ALLOWABLE TRENCH WIDTH SHALL BE THE GREATER OF 36" OR 2X THE NOMINAL PIPE DIAMETER. MINIMUM TRENCH WIDTH SHALL BE 36".
- 2. WHERE GRASS OCCURS, LOAM AND SEED ALL DISTURBED AREAS TO A MINIMUM DEPTH OF 4 INCHES UNLESS OTHERWISE NOTED. WHERE NO GRASS OCCURS, MATCH EXISTING MATERIALS AND DEPTHS OR PLACE A MINIMUM OF 6 INCHES OF GRAVEL, WHICHEVER IS GREATER.
- 3. REFER TO TYPICAL ROADWAY SECTIONS.


DRAIN TRENCH DETAIL

NOT TO SCALE

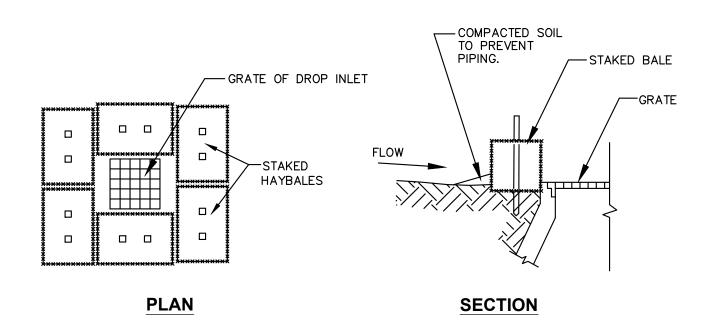

HAY BALE SILT TRAP DETAIL


NOT TO SCALE

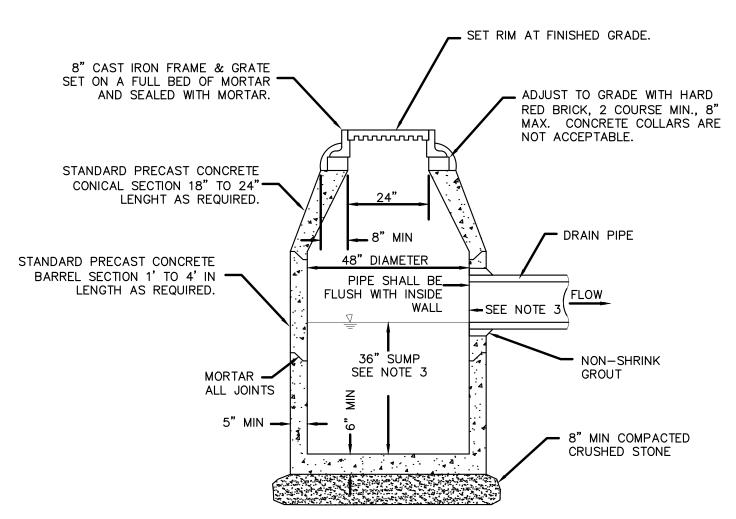

NOTES

- PRECAST CONCRETE SECTION ASSEMBLIES SHALL WITHSTAND H-20 LOADING AND SHALL CONFORM TO ASTM C478.
- 2. ECCENTRIC CONE SECTIONS MAY BE USED.
- 3. INSTALL OIL-DEBRIS HOOD AT CB #4B. FURNISH AND INSTALL HOOD AND PROVIDE SUMP DEPTH IN ACCORDANCE WITH MANUFACTURER RECOMMENDATIONS. ALL HOODS SHALL BE FROM THE SAME MANUFACTURER. HOOD SHALL BE THE "SNOUT" AS MANUFACTURER BY BEST MANAGEMENT PRACTICES, INC., LYME CT. OR EQUAL.

CATCH BASIN DETAIL NOT TO SCALE

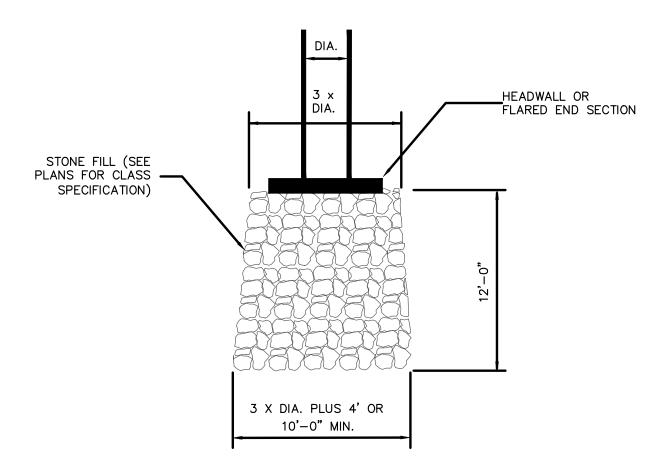


NOTES

- 1. NON WOVEN FILTER FABRIC SHALL BE PLACED ON A PREPARED SUBBASE AND ROLLS SHALL BE OVERLAPPED A MINIMUM OF 12 INCHES. CARE SHALL BE TAKEN NOT TO PUNCTURE THE FABRIC DURING INSTALLATION AND ANY DAMAGED AREAS SHALL BE REPAIRED TO THE SATISFACTION OF THE ENGINEER.
- 2. STONE FILL SHALL CONFORM TO NHDOT STONE SIZE CLASSIFICATIONS AND SHALL BE PLACED WITH A MINIMUM THICKNESS AS FOLLOWS:
 - A. CLASS C STONE FILL MINIMUM THICKNESS 12 INCHES B. CLASS B STONE FILL MINIMUM THICKNESS 18 INCHES

STONE APRON DETAIL

NOT TO SCALE

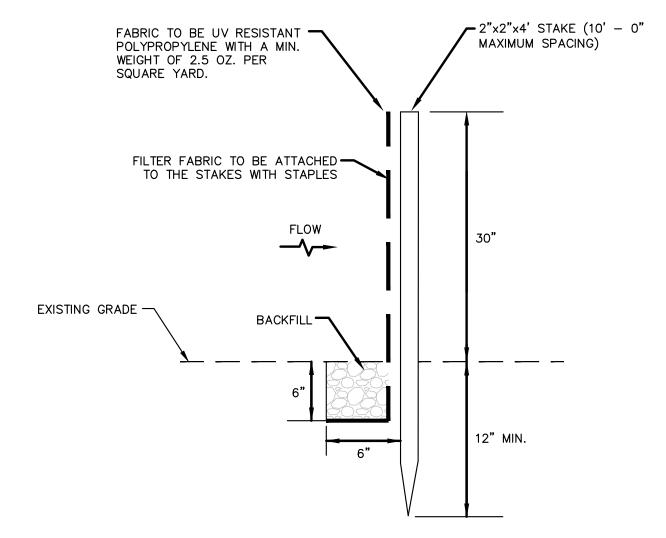


DTES:


1. INSTALL HAY BALES AS DIRECTED BY THE ENGINEER.

SILT FENCE DETAIL

NOT TO SCALE

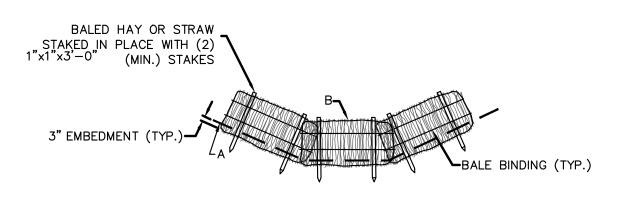

SECTION

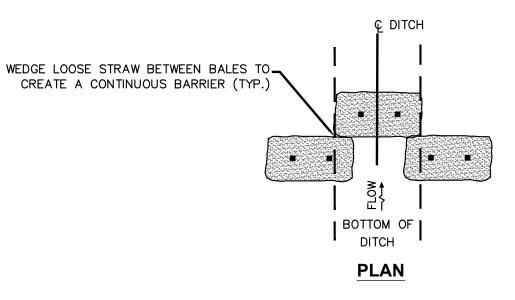


NOTES:

- THE BALES ARE TO BE EMBEDDED A MINIMUM OF 3" INTO THE EXISTING GROUND, ROADWAY SLOPE OR DITCH SECTION.
- 2. POINT "A" SHOULD BE AT A HIGHER ELEVATION THAN POINT "B."
- 3. BARRIERS SHALL BE INSTALLED AT 50 FOOT INTERVALS ALONG THE CENTERLINE OF THE PROPOSED DRAINAGE DITCHES, OR AS DIRECTED BY THE ENGINEER, UNTIL PERMANENT SURFACE TREATMENTS ARE INSTALLED AND FULLY STABILIZED.

EROSION CHECK DAM DETAIL NOT TO SCALE

			REVISIONS
NUMBER	DATE	BY	DESCRIPTION

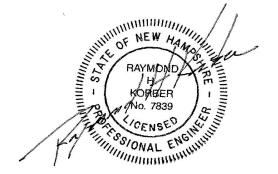

KV Partners consulting engineers	PC
	GII
CONSULTING ENGINEERS	TE

PO BOX 7721 PO BOX 432
GILFORD, NH 03247 NEW BOSTON
TEL: (603) 513-1909 TEL: (603) 413

3247 NEW BOSTON, NH 03070 909 TEL: (603) 413-6550 www.kvpllc.com

SCALE:	AS NOTED	
DESIGNED BY:	RHK	
DRAWN BY:	NMT	
CHECKED BY:	RHK	
APPROVED BY:	RHK	

07-12-12

2012 ROAD PROGRAM - SHERIDAN ROAD MOULTONBOROUGH, NEW HAMPSHIRE

DRAINAGE AND MISCELLANEOUS DETAILS

SHEET NO.

SHEET 8 OF 8